

NATIONAL SENIOR CERTIFICATE

GRADE 12

ENGINEERING GRAPHICS AND DESIGN P1 NOVEMBER 2017

MARKS: 200

TIME: 3 hours

INSTRUCTIONS AND INFORMATION

- 1. This question paper consists of FOUR questions.
- 2. Answer ALL the questions.
- 3. ALL drawings are in first-angle orthographic projection, unless otherwise stated.
- 4. ALL drawings must be completed using pencil and instruments, unless otherwise stated.
- 5. ALL answers must be drawn accurately and neatly.
- 6. ALL the questions must be answered on the QUESTION PAPER, as instructed.
- 7. ALL the pages, irrespective of whether the question was attempted or not, must be re-stapled in numerical sequence in the TOP LEFT-HAND CORNER ONLY.
- 8. Proper planning is essential in order to complete all the questions.
- 9. Print your examination number in the block provided on every page.
- 10. Any details or dimensions not given must be assumed in good proportion.

FOR OFFICIAL USE ONLY															
QUESTION	MARK	S OBTA	AINED	1/2	SIGN	MODERATED		1/2	SIGN	RE-MARKING		NG	1/2	SIGN	
1															
2															
3															
4															
TOTAL															
	2	0	0			2	0	0			2	0	0		

FINAL CONVERTED MARK	CHECKED BY
100	

This question paper consists of 6 pages.

Barcode label

COMPLETE THE FOLLOWING:

CENTRE NUMBER

CENTRE NUMBER

EXAMINATION NUMBER

EXAMINATION NUMBER



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Please turn over

NSC Engineering Graphics and Design/P1 DBE/November 2017



CORNER HEIGHTS AND BOUNDARY LENGTHS IN METRES									
Α	137,38	AB	143,56						
В	134,67	вс	223,91						
С	133,5	CD	143,89						
D	136	DA	223,87						

SYMBOL LEGEND:

- 1. 25 m HIGH LAMP POSTS SPACED MAXIMUM 50 m c/c
- 2. EXISTING PALM TREES
- 3. NEW DECIDUOUS TREES

Contractors must verify all dimensions and levels on site before commencing work. Architects to be notified immediately of any discrepancies.

ARCHITECT'S SIGNATURE .

CLIENT'S SIGNATURE

ANSWER 20

In the space below, draw, in nea freehand, the front view and top view of the SANS 10143 graphical symb for a WASHTUB.

QUESTION 1: ANALYTICAL (CIVIL)

The site plan of an existing warehouse with a proposed new logistics centre and guard house, a title panel and a table of questions. The drawing has not been prepared to the indicated scale.

Complete the table below by neatly answering the questions which refer to the accompanying drawing and title panel.

	QUESTIONS	ANSWERS			
1	Who checked the drawing?		1		Ī
2	What is the number of the stand?		1		Ī
3	What is the number of the electrical substation?		1		1
4	How far is the refuelling point from the fuel tanks in metres?		1		
5	How deep is the municipal sewerage connection?		1		
6	How many gullies are shown?		1		
7	What does the abbreviation IE stand for?		1		1
8	How many palm trees are shown?		1		
9	What is the maximum permitted distance between the lamp posts in metres?		1		
10	What is the combined capacity of the underground fuel tanks in cubic litres?		2		
11	Besides the trees, what other natural feature is indicated?		1		
12	What does the line at 1 indicate?		1		
13	What does the line at 2 indicate?		1		
14	Name the feature at 3.		1		
15	In what colour must a new sewerage line be indicated on a drainage plan?		1		
16	Which elevation of the proposed new logistics centre faces the new staff parking?		2		
17	What is the distance between the boundary line and the building line on the north eastern side of the stand in metres?		2		
18	In the space below (ANSWER 18), determine the perimeter of the s	stand in metres.	3		
In the space below (ANSWER 19), determine the total area of the proposed new logistics centre in square metres.					
In the space in the title panel (ANSWER 20), draw, in neat freehand, the front view and top view of the SANS 10143 graphical symbol for a WASHTUB.					
		TOTAL	30		-

EXISTING 2 x 70 CUBIC LITRE UNDERGROUND FUEL STAND 7391 STORAGE TANKS 6000 BL REFUELLING POINT 4 m TRUCK ENTRANCE m HIGH SECURITY FENCE 30000 EXISTING GUARD HOUSE STAND 7392 2000 KVA ELECTRICAL SUBSTATION No. 8789 EXISTING TRUCK PARKING 50-YEAR FLOOD LINE **EXISTING WAREHOUSE** WILDEBEEST DRIVE NEW STAFF PARKING ORANGE RIVER PROPOSED NEW LOGISTICS MOTOR VEHICLE ENTRANCE CENTRE NEW PUBLIC PARKING PROPOSED NEW **GUARD HOUSE STAND 7393** \мн **GENERAL NOTES:** ALL NEW DRIVEWAYS AND PARKING AREAS LAID ON WELL-(2)COMPACTED HARDCORE WITH A 50 mm ASPHALT FINISH MUNICIPAL SEWER-CONNECTION 1,2 m DEEP SITE PLAN SCALE 1: 1500

2 2017-01-09 Security lighting 2017-01-07 New staff parking REVISION DATE DESCRIPTION 3D STUDIO **ARCHITECTS** 1024 FOREST DRIVE ISIPINGO **2** 031 555 2792 PRINTED BY DATE OF PRINT FAST PRINT 2017-01-28 DRAWING TITLE SITE PLAN PROJECT PROPOSED NEW LOGISTICS CENTRE AND GUARD HOUSE FOR RAGE INDUSTRIES

ON PLOT 7392, RIVER HORSE INDUSTRIAL

DRAWING NUMBER

CHECKED

LUKE

LF 5-10-BPK/N

SCALE

1:1500

PARK, 28 WILDEBEEST DRIVE, ISIPINGO

PROJECT NUMBER

REFERENCE CODE V1V1-2017

DATE

2017-01-05

SSA/FS/-2015

DRAWN

NM

21000 PROPOSED NEW LOGISTICS CENTRE 67500 **EXAMINATION NUMBER EXAMINATION NUMBER**

ANSWER 19 Show ALL calculations.

ANSWER 18 Show ALL calculations.



QUESTION 2: SOLID GEOMETRY

Given:


- The front view and the top view of a right regular hexagonal prism with a right regular hexagonal pyramidal hole
- Cutting plane A-A


Instructions:

Draw, to scale 1:1, the following views of the solid:

- 2.1 The given front view2.2 A sectional top view
- 2.3 A sectional left view
- 2.4 The true shape of the cut surface
- Show ALL hidden detail.
- Show ALL construction.


[35]

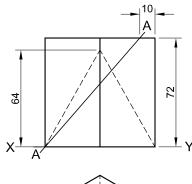

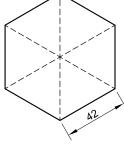

	ASSESSMENT CRITERIA									
1	FRONT VIEW	4								
2	SECTIONAL TOP VIEW	9½								
3	SECTIONAL LEFT VIEW	10½								
4	TRUE SHAPE	6								
5	HATCHING	5								
PE	ENALTIES (-)									
	TOTAL	35								
	EXAMINATION NUMBER									

EXAMINATION NUMBER

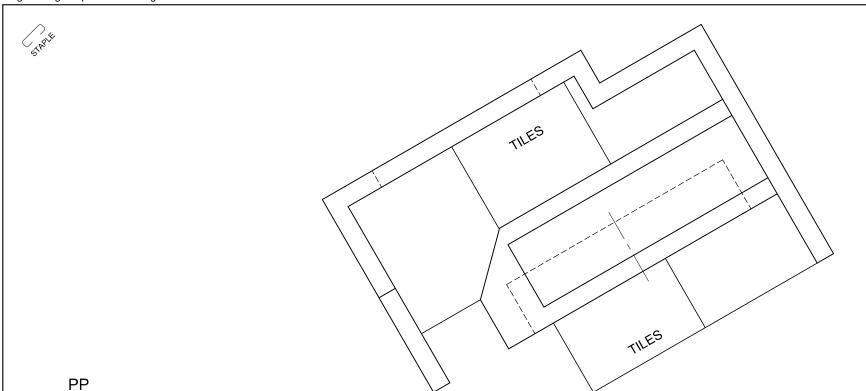

QUESTION 3: PERSPECTIVE

Given:

Three views of a serving area and the information needed to draw a two-point perspective drawing

PP - Picture plane

HL - Horizon line

GL - Ground line

SP - Station point

Instructions:


Complete the perspective drawing.


- Align the drawing sheet with the ground line (GL).
- Determine and label the vanishing points.
- Show ALL construction.
- NO hidden detail is required.

[40]

HL

DBE/November 2017

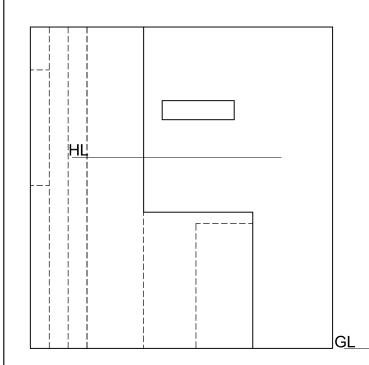

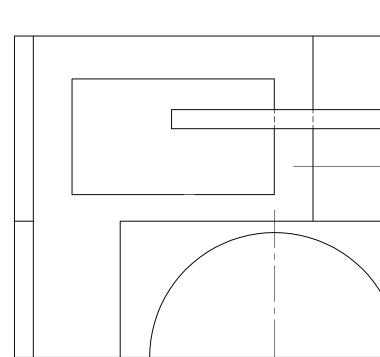


	ASSESSMENT CRITERIA										
1	CONSTRUCTION	6									
2	WALLS AND WINDOW	17½									
3	SERVING AREA										
4	4 SEMICIRCLE										
PEI	NALTIES (-)										

EXAMINATION NUMBER

TOTAL 40 EXAMINATION NUMBER

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QUESTION 4: CIVIL DRAWING

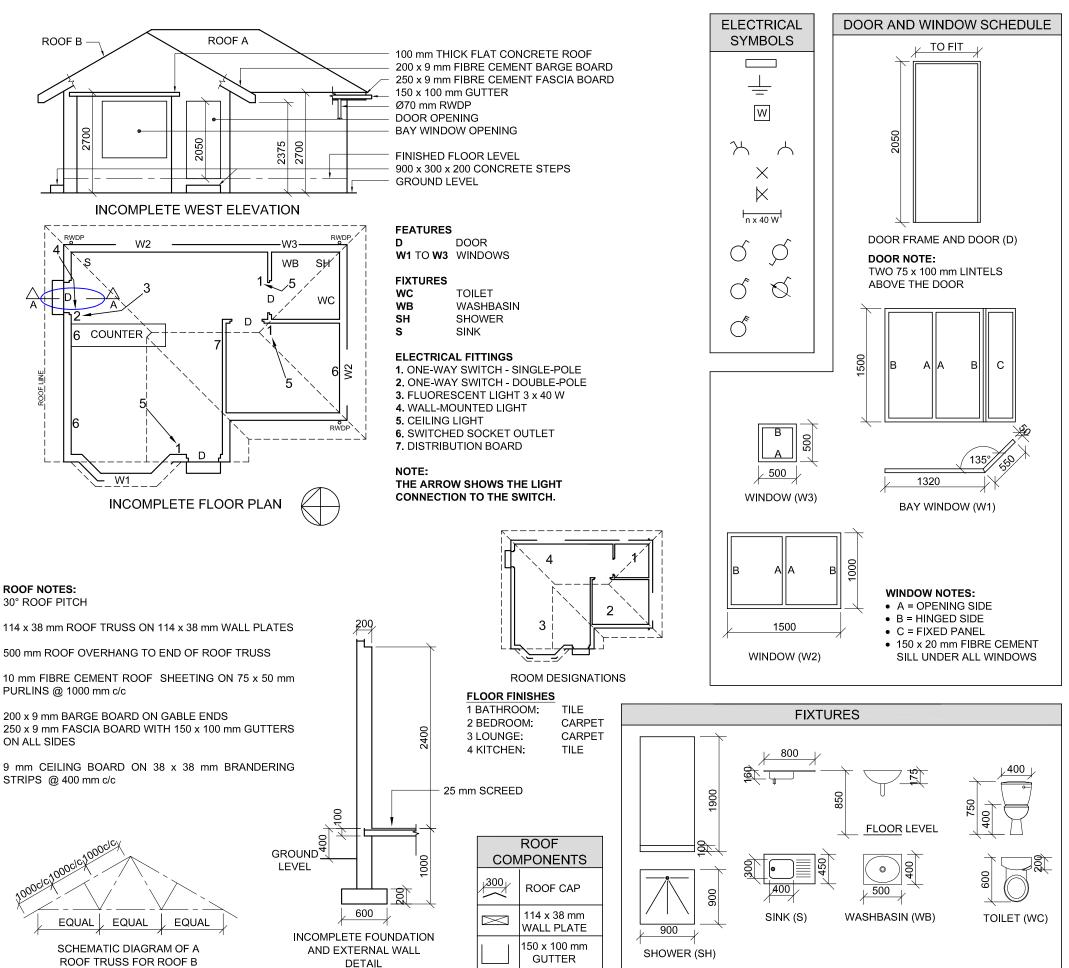Given:

- The incomplete west elevation of a new house, showing the walls, the door and window openings, the roof and notes
- The incomplete floor plan showing the walls, positions of the doors, windows, fixtures and the electrical layout
- A schematic diagram of a roof truss and roof notes
- Room designations and floor finishes
- The incomplete foundation and external wall detail
- A table of roof components
- A table of electrical symbols
- A door and window schedule
- A table of fixtures
- The incomplete floor plan of the **new house**, drawn to scale 1:50, and the incomplete foundation of the detailed section, drawn to scale 1:20, on page 6

Instructions:

Answer this question on page 6.

4.1 Using the given incomplete floor plan, draw, in first-angle orthographic projection and to scale 1 : 50, the following views of the **new house**:

4.1.1 THE COMPLETE FLOOR PLAN

Add the following features to the drawing:

- ALL doors and windows
- The fixtures as indicated by the abbreviations
- ALL electrical fittings as indicated by the numbers
- ALL hatching detail

4.1.2 THE COMPLETE WEST ELEVATION

Show the following features on the drawing:

- The outside walls, door and window detail
- The roof detail, including the barge boards, fascia boards, gutters and rainwater down-pipe
- The finished floor level
- 4.2 Using the incomplete foundation on page 6, draw, to scale 1 : 20, a **DETAILED SECTION** on cutting plane A-A of the area in the ellipse shown on the incomplete floor plan

Show the following features on the drawing:

- The foundation and external wall detail
- The door detail
- The roof detail, including the fascia board and gutter
- The sink
- ALL hatching detail. ONLY the substructure hatching may be drawn in neat freehand.

Label the following:


- The west elevation
- The room designations and floor finishes
- Ground level, finished floor level and damp-proof course (use the correct abbreviations and show it on ALL the relevant views)

NOTE:

ALL drawings must comply with the **guidelines** and **graphical symbols** as contained in the *SANS 10143*. **[95]**




5

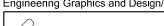

FOR OFFICIAL USE ONLY	
INCORRECT SCALE	
NON-ALIGNMENT OF VIEWS	
VIEW(S) ROTATED	
SECTION VIEWED INCORRECTLY	
INCORRECT LETTERING	
TOTAL	

MARK ALLOCATION FOR ROOF SECTION										
Α	В	С	D	Е	F	G	Н	I	J	

	ASSESSMENT CRITERIA									
FLOOR PLAN										
		POSSIBLE	OBTAINED	SIGN	MODERATED					
1	DOORS + WINDOWS	13½								
2	ELECTRICAL	9½								
3	FIXTURES	8½								
4	HATCHING	3								
5	LABELS	4								
;	SUBTOTAL	38½								
	V	VEST ELE	EVATION							
1	ROOF + RWDP	12								
2	WALLS + FFL	6½								
3	DOOR + WINDOW	8								
4	LABELS	1½								
:	SUBTOTAL	28								
	DE	TAILED	SECTION	ı						
1	ROOF DETAIL	11								
2	FOUNDATION + WALL + DOOR	9								
3	SINK	3								
4	HATCHING	4½								
5 LABELS		1								
;	SUBTOTAL	28½								
	TOTAL	95								
PEI	VALTIES (-)									
	GRAND TOTAL									
EXAMINATION NUMBER										
		(A B AID I A T C	LAUMAN		10					
EXAMINATION NUMBER 6										

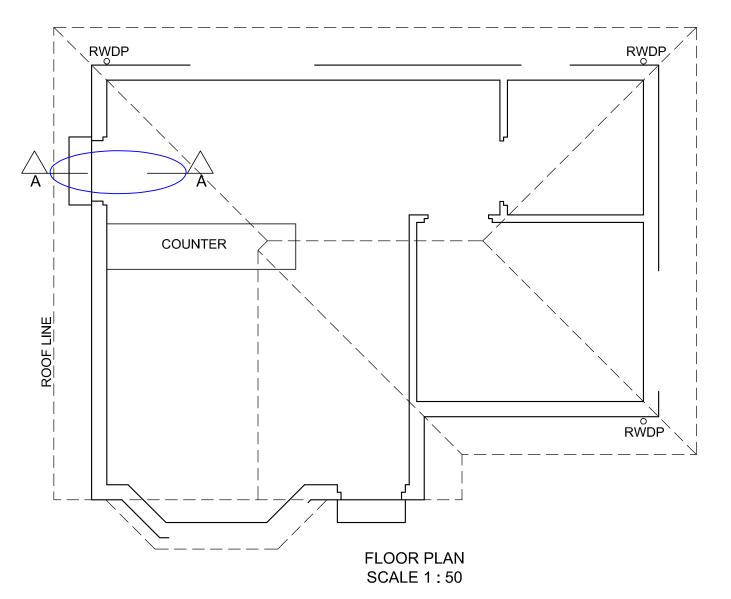

DETAILED SECTION A-A SCALE 1 : 20