



## NATIONAL SENIOR CERTIFICATE

**GRADE 12** 

# ENGINEERING GRAPHICS AND DESIGN P1 FEBRUARY/MARCH 2016

MARKS: 100 TIME: 3 hours

This question paper consists of 6 pages.

## INSTRUCTIONS AND INFORMATION

- 1. This question paper consists of FOUR questions.
- 2. Answer ALL the questions.
- 3. ALL drawings are in first-angle orthographic projection, unless otherwise stated.
- 4. ALL drawings must be completed using instruments, unless otherwise stated.
- 5. ALL answers must be drawn accurately and neatly.
- 6. ALL the questions must be answered on the QUESTION PAPER as instructed.
- 7. ALL the pages, irrespective of whether the question was attempted or not, must be re-stapled in numerical sequence in the TOP LEFT-HAND CORNER ONLY.
- 8. Proper planning is essential in order to complete all the questions.
- 9. Print your examination number in the block provided on every page.
- 10. Any details or dimensions not given must be assumed in good proportion.


FOR OFFICIAL USE ONLY															
QUESTION	MARKS OBTAINED $\frac{1}{2}$ SIGN		SIGN	MODERATED		1/2	SIGN	RE-MARKING		NG	1/2	SIGN			
1															
2															
3															
4															
TOTAL															
	2	0	0			2	0	0			2	0	0		

FINAL CONVERTED MARK	CHECKED BY
<u> </u>	
100	

COMPLETE THE FOLLOWING:						
CENTRE NUMBER						
CENTRE NUMBER						
EXAMINATION NUMBER						
EXAMINATION NUMBER						



Engineering Graphics and Design/P1 NSC DBE/Feb.-Mar. 2016

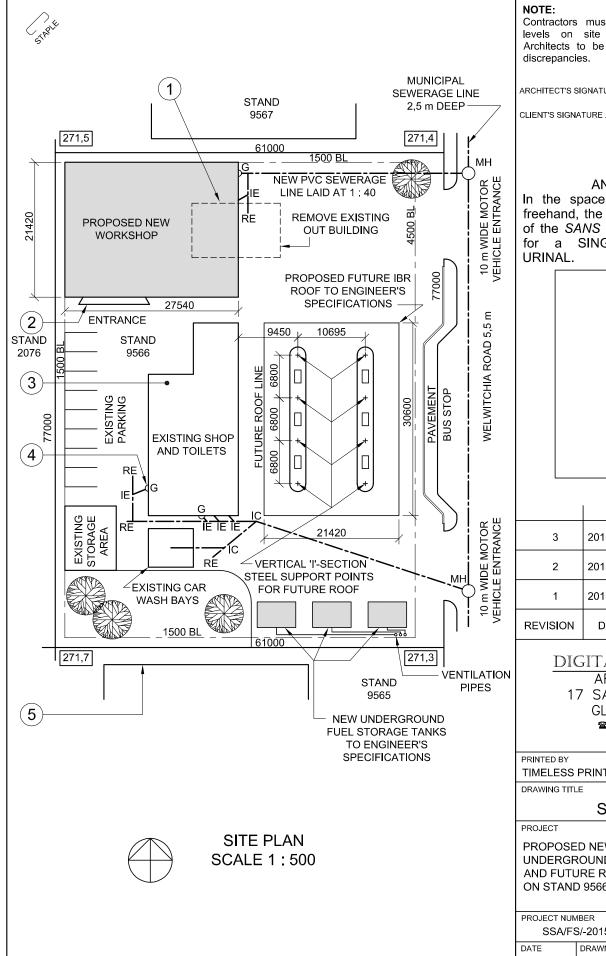

#### NOTE:

Contractors must verify all dimensions and levels on site before commencing work. Architects to be notified immediately of any discrepancies.

ARCHITECT'S SIGNATURE .

#### ANSWER 20

freehand, the front view and top view of the SANS 10143 graphical symbol for a SINGLE WALL-MOUNTE

In the space below, draw, in nea URINAL.

#### Replace fuel tanks 2 2015-08-18 Include new roof 2015-08-06 support points REVISION DATE DESCRIPTION

2015-08-30

Move vent pipes

#### DIGITAL DRAWING ARCHITECTS 17 SAFFRON DRIVE **GLENASHLEY 2** 031 5836092

PRINTED BY DATE OF PRINT TIMELESS PRINTERS 2015-10-17

DRAWING TITLE

3

#### SITE PLAN

PROJECT

PROPOSED NEW WORKSHOP. UNDERGROUND FUEL STORAGE TANKS AND FUTURE ROOF FOR SA PETROLEUM ON STAND 9566, WELWITCHIA ROAD

PROJECT NUM	1BER	DRAWING NUMBER			
SSA/FS	S/-2015	TH 15-05-R4K/J			
DATE	DRAWN	CHECKED	SCALE		
2015-09-04	TOM	HARRY	1:500		

REFERENCE CODE 1QP1-2015


#### **QUESTION 1: ANALYTICAL (CIVIL)**

The site plan of an existing service station with a proposed new workshop, underground fuel storage tanks and future roof, a title panel and a table of questions. The drawing has not been prepared to the indicated scale.

Complete the table below by neatly answering the questions, which refer to the accompanying drawing and title panel. [30]

		QUESTIONS	ANSWERS		
at w	1	How many signatures are required?		1	
ool ED	2	What is the architectural firm's telephone number?		1	
ים	3	What was the second revision?		1	
	4	What is the width of Welwitchia Road in millimetres?		1	
	5	What type of roof cover is proposed for the future roof?		1	
	6	How many trees are shown?		1	
	7	How many new underground fuel storage tanks are shown?		1	
	8	What does the broken line at 1 indicate?		1	
	9	Name the feature at 2.		1	
	10	In what colour should new steel be indicated on a drawing?		1	
	11	In what colour should the feature at 3 be shown?		1	
	12	Name the feature at 4.		1	
	13	Name the feature at 5.		1	
	14	Which side of the existing shop and toilets faces Welwitchia Road?		2	
s	15	Give a reason why graphical symbols are used in drawings.		2	
	16	What determines the size of a graphical symbol on a drawing?		1	
	17	What is the height of the lowest corner of the stand in metres?		2	
	18	In the space below, determine the perimeter of the existing shop and toilets in metres.		3	
	19	In the space below, determine the total area of the existing shop and toilets in square metres.		3	
	20	In the space provided in the title panel, draw, in neat freehand, the front view and top view of the <i>SANS 10143</i> graphical symbol for a SINGLE WALL-MOUNTED URINAL.		4	
			TOTAL	30	

**ANSWER 18** Show ALL calculations.

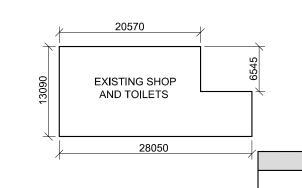

**ANSWER 19** Show ALL calculations.

**EXAMINATION NUMBER** 

**EXAMINATION NUMBER** 



## **QUESTION 2: SOLID GEOMETRY**

## Given:


The front view and an auxiliary view of a truncated right regular hexagonal pyramid with a centrally placed right square pyramidal hole.

## Instructions:

Draw, to scale 1:1, the following views of the


- 2.1 The given front view2.2 The top view2.3 The left view

- Show ALL hidden detail.
- Show ALL necessary construction. [40]

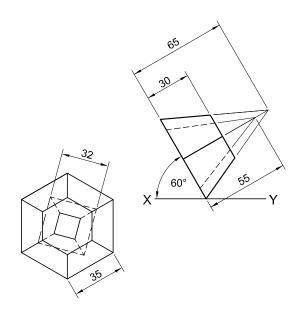

ASSESSMENT CRITERIA									
1	FRONT AND AUX. VIEW	7\frac{1}{2}							
2	TOP VIEW	15							
3	LEFT VIEW	17½							
PEI	NALTIES (-)								
TOTAL 40									
EXAMINATION NUMBER									
EXAMINATION NUMBER									



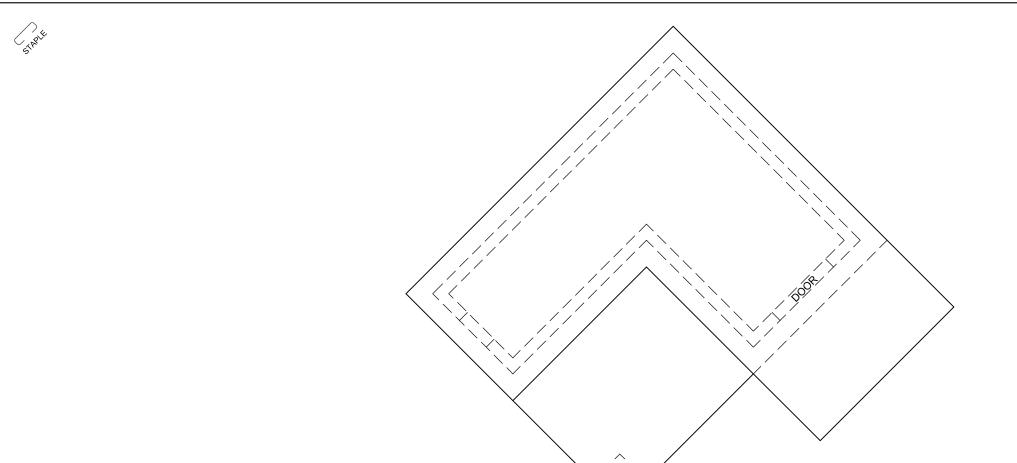

## **QUESTION 3: PERSPECTIVE**

#### Given:

Three views of a double-storey dwelling and the information needed to draw a two-point perspective drawing.

PP - Picture plane

HL - Horizon line

GL - Ground line

SP - Station point


## Instructions:


Complete the perspective drawing.

- Align the drawing sheet with the ground line (GL).Determine and label the vanishing points.
- Show ALL necessary construction.
- NO hidden detail is required.

[39]

ASSESSMENT CRITERIA								
1	CONSTRUCTION + VPs	5						
2	FLOOR	4						
3	GROUND FLOOR	12						
4	FIRST FLOOR	12						
5	WINDOW + DOOR	6						
PENA	LTIES (-)							
	TOTAL	39						

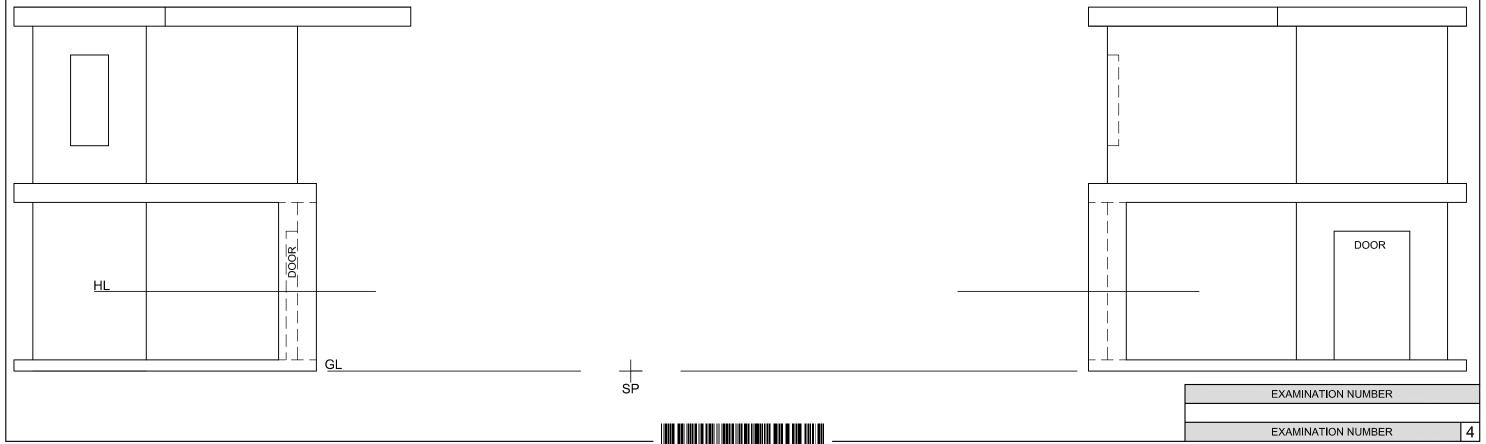

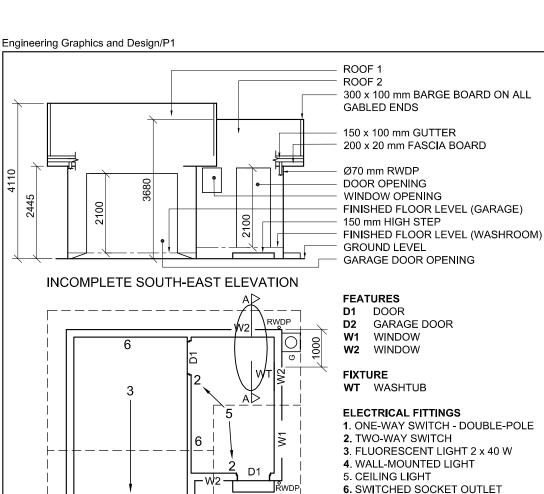

D2

20 mm SCREED

CONCRETE SLAB

ON 80 mm

600

INCOMPLETE FOUNDATION

AND EXTERNAL WALL

DETAIL OF THE GARAGE


INCOMPLETE FLOOR PLAN

## 300 x 100 mm BARGE BOARD ON ALL GABLED ENDS 150 x 100 mm GUTTER 200 x 20 mm FASCIA BOARD Ø70 mm RWDP DOOR OPENING WINDOW OPENING FINISHED FLOOR LEVEL (GARAGE)

**ROOM DESIGNATIONS** 


**FLOOR FINISHES** 1 GARAGE:

**GRANO** 2 WASHROOM: TILE

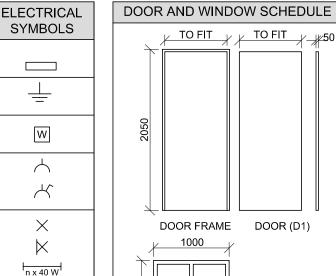

HINGED SIDE **OPENING SIDE** FIXED PANEL

WINDOW FRAME (W1)

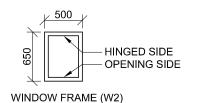

RAINWATER


**ITEMS** 


Ø 70

90

RWDP

150 x 20 mm FIBRE CEMENT SILL UNDER **ALL WINDOWS** 

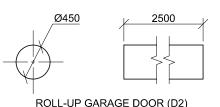

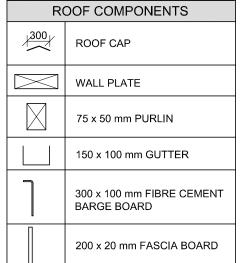

#### Given: V TO FIT V TO FIT V 50 • The incomplete south-east elevation of a new garage and washroom showing the walls, the garage door opening, the door and window openings, the roof and notes • The incomplete floor plan showing the walls, position of the doors, windows, fixture and the electrical layout • The incomplete foundation and external wall detail of the

 Room designations and floor finishes • Schematic diagrams of the TWO types of roof trusses and

garage and of the washroom

**QUESTION 4: CIVIL DRAWING** 

• A table of electrical symbols

• A table of rainwater items

A table of the fixture

A door and window schedule

• A table of roof components

• The incomplete floor plan of the new garage and washroom, drawn to scale 1:50, on page 6

#### Instructions:

Answer this question on page 6.

4.1 Using the given incomplete floor plan, draw, in first-angle orthographic projection and to scale 1:50, the following views of the new garage and washroom:

#### 4.1.1 THE COMPLETE FLOOR PLAN

## Add the following features to the drawing:

ALL doors and windows

• The fixture as indicated by the abbreviation

• ALL electrical fittings as indicated by numbers

ALL hatching detail

## 4.1.2 THE COMPLETE SOUTH-EAST ELEVATION Show the following features on the drawing:

• The outside walls, door and window detail

• The roof detail, including the fascia boards, barge boards, gutters, rainwater down-pipe and gulley

• The finished floor level

4.2 In the space provided, draw, to scale 1: 20, a **DETAILED SECTION** on cutting plane A-A of the area in the ellipse shown on the incomplete floor plan.

#### Show the following features on the drawing:

The complete foundation and external wall detail

The window detail, with a DOUBLE lintel

• The roof detail, including the fascia board and gutter

• ALL features and fixtures to the right of the section

• ALL hatching detail. ONLY the substructure hatching may be drawn in neat freehand.

#### Label the following:

The south-east elevation

• The room designations and floor finishes

• Using the correct abbreviations, label the following features in the correct view: ground level, finished floor level and damp-proof course.


#### NOTE:

· Planning is essential.

• ALL drawings must comply with the guidelines and graphical symbols as contained in the SANS 10143.

[91]

## THE ARROW SHOWS THE LIGHT CONNECTION TO THE SWITCH. 1200 clc x 1200 clc x 1200 clc **EQUAL EQUAL EQUAL EQUAL** SCHEMATIC DIAGRAM OF A 150 TRUSS FOR ROOF '1' 1200 clc > **EQUAL EQUAL**

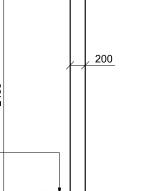

**ROOF NOTES:** ROOF PITCH 20°

DOOR

NOTE:

WINDOW

WINDOW

GARAGE DOOR

200 x 20 mm FASCIA BOARD ON ALL SIDES AND 300 x 20 mm BARGE BOARD ON THE **GABLED ENDS** 

SCHEMATIC DIAGRAM OF A


TRUSS FOR ROOF '2'

ROOF COVER 15 mm FIBRE CEMENT SHEETING ON 75 x 50 mm PURLINS SPACED ACCORDING TO SCHEMATIC DIAGRAMS

114 x 38 mm ROOF TRUSS ON 114 x 38 mm WALL PLATES


9 mm CEILING BOARD ON 38 x 38 mm BRANDERING STRIPS @ 400 mm c/c

100 x 150 mm GUTTER ON ALL SIDES

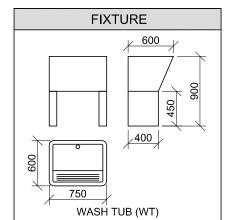

450

GULLEY (G)

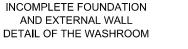


600

GROUND

LEVEL



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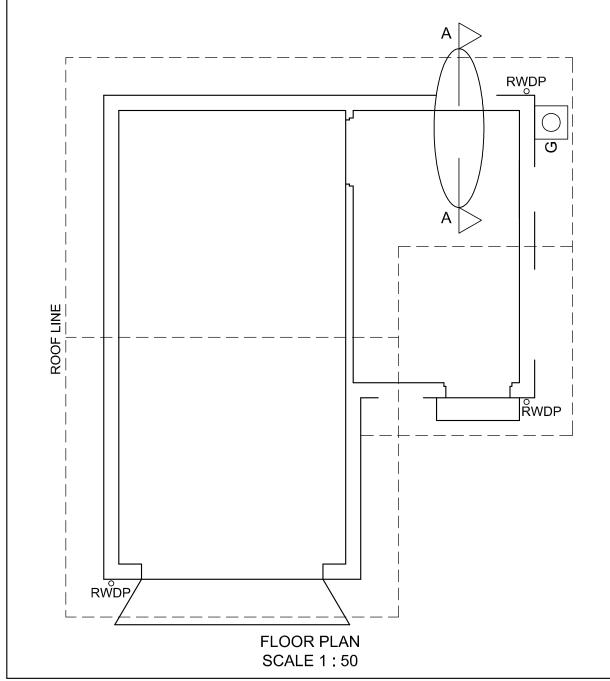
	FOR OFFICIAL USE ONLY	
	INCORRECT SCALE(S)	
	NON-ALIGNMENT OF VIEWS	
	VIEW(S) ROTATED	
	SECTION VIEWED INCORRECTLY	
	INCORRECT LETTERING	
	TOTAL PENALTIES (-)	

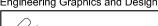MARK ALLOCATION FOR SECTION OF ROOF (4.2 No 1)									1)				
	Α	В	С	D	Е	F	G	Ι	ı	J	K	L	

ASSESSMENT CRITERIA											
	FLOOR PLAN										
		POSSIBLE	OBTAINED	SIGN	MODERATE						
1	DOORS + WINDOWS	12									
2	ELECTRICAL	8									
3	FIXTURE	2									
4	HATCHING	4									
5	LABELS	2									
;	SUBTOTAL	28									
	SOUT	ΓH-EAST	ELEVAT	ON							
1	ROOF + RWDP	9									
2	WALLS + FFL + GULLEY + STEP + RAMP	6 <sup>1</sup> / <sub>2</sub>									
3	DOOR + WINDOW	$7\frac{1}{2}$									
4	LABELS	2									
,	SUBTOTAL	25									
	DE	TAILED	SECTION								
1	ROOF DETAIL + RWDP	16									
2	FOUNDATION + WALL + SLAB + LINE BREAK	9									
3	WINDOW + WT	8									
4	HATCHING	4									
5	LABELS	1									
,	SUBTOTAL	38									
	TOTAL	91									
то	TAL PENALTIES	S (-)									
	GRAND TOTAL										
	EX	OITANIMA	NUMBER								

EXAMINATION NUMBER

6



DETAILED SECTION ON A-A
SCALE 1:20

